



DATE & TIME: January 6, 2021 10:40
PLOTTER: BY: STEVE

FILE NAME & LOCATION: EN-Pro-ELECTRIC-Design-Intake-Summary-Summary-2020-Vor-Landing

- OPERATIONS COMPONENTS - LEGEND
- 1 GRADED WORKING SURFACE
 - 2 GRADED AND MAINTAINED WORK AREAS BOTH SIDES OF FLUME. APPEARS FOR PROTECTION, ACCESS AND MAINTENANCE.
 - 3 GRAVEL ACCESS ROAD AND WORK AREA DONE AFTER 2019 WORK IN WATER, SURFACE CRUSHED ROCK
 - 4 SHORELINE RIP RAP
 - 5 WOOD DIVERSION SPILLWAY
 - 6 ROCK CHUTES
 - 7 INTAKE TO FLUME
 - 8 FLOOD GATES

- 9 BRIDGE CROSSING RIVER
- 10 FISH LADDER
- 11 RUNOFF BIO-TREATMENT AREA
- 12 GRADING FROM CONSTRUCTION ACTIVITY
- 13 UPPER LANDING STORAGE, ASSEMBLY AND CONCRETE PLANT
- 14 ROCK STORAGE
- 15 MAINTAINED DRAINAGE $\pm 1,100'$

- 16 DE-WATERING SEDIMENT POND/ACCLIMATION POND
- 17 CONCRETE ABUTMENT AND TEMPORARY ROCK FILL DAM

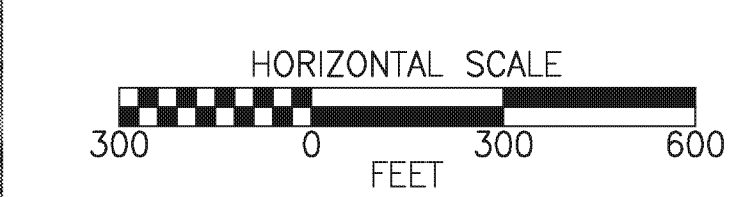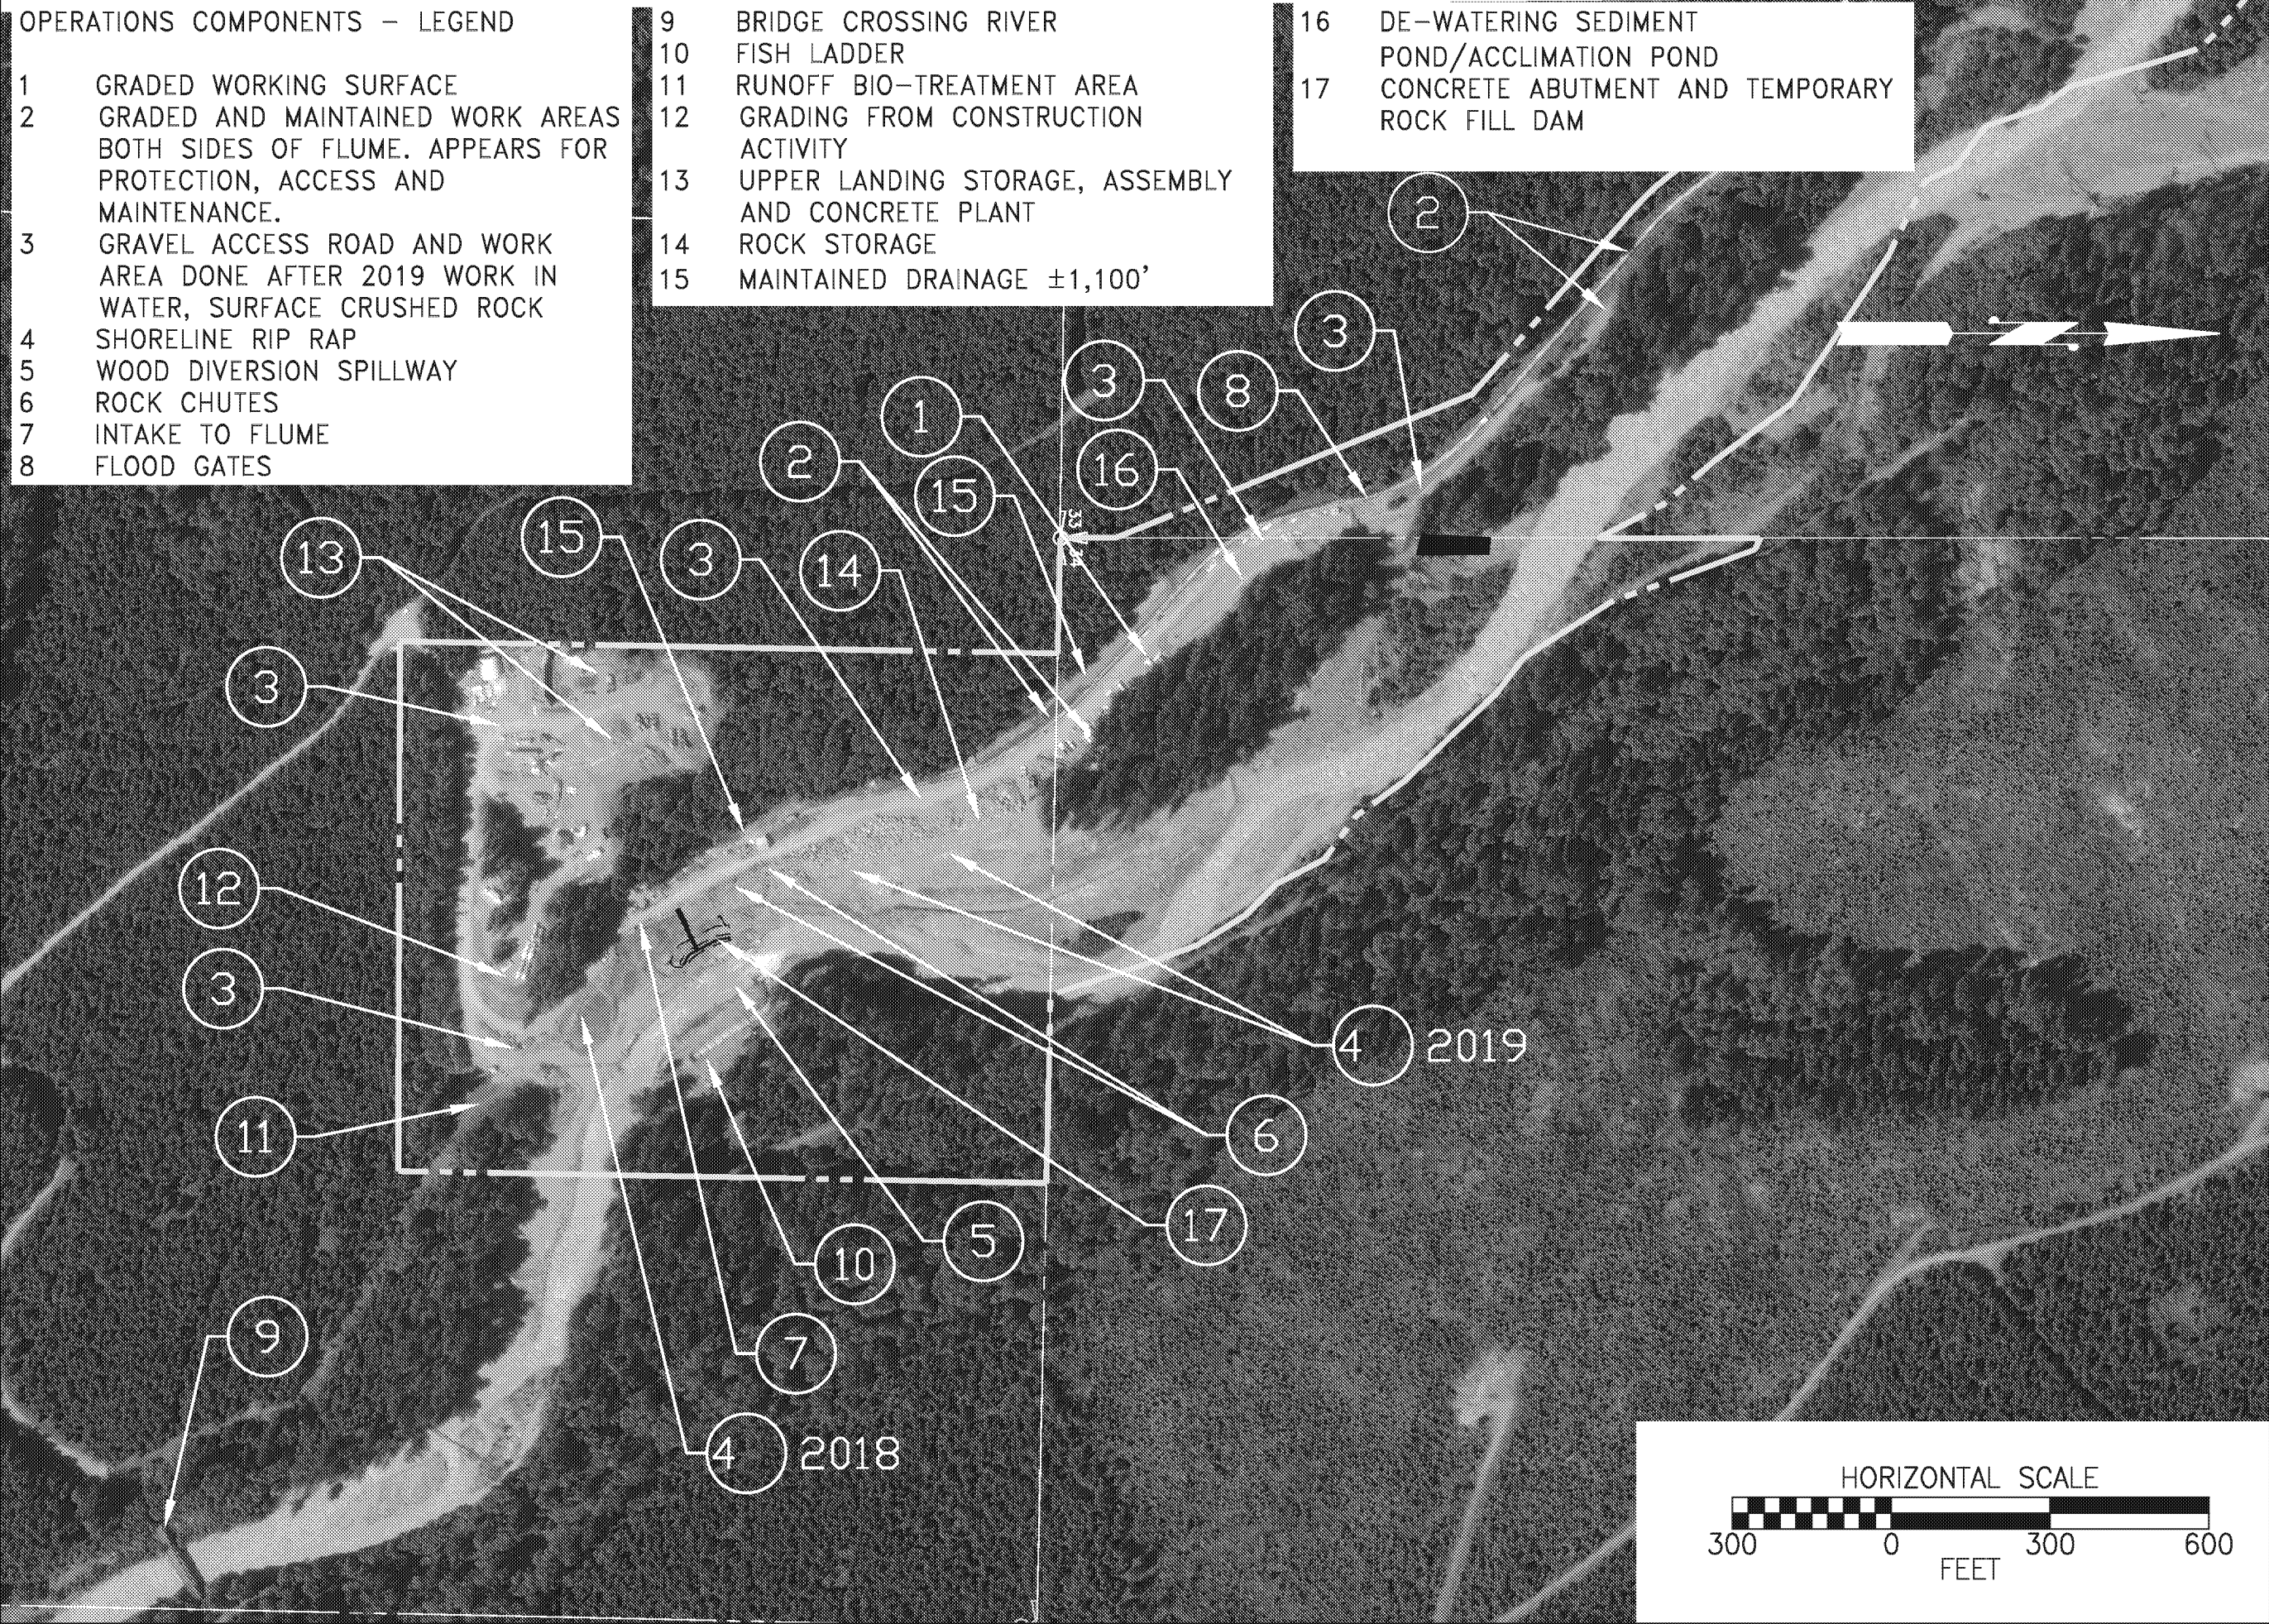

ELECTRON HYDROELECTRIC PROJECT	
SITE PLAN 2020-08-10	
PIERCE COUNTY	WASHINGTON
Scale: 1" = 300'	
DESIGN:	SPG
DRAWN:	
CHECKED:	
DATE:	1/6/2021
JOB#:	11011900
SHEET 8	OF 15
DRAWING 8	

NO.	DATE	REVISION	BY	CK
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